

JOINT PUBLIC NOTICE
January 29, 2008

DEPARTMENT OF THE ARMY
NEW ORLEANS DISTRICT
CORPS OF ENGINEERS
REGULATORY FUNCTIONS BRANCH
P.O. BOX 60267
NEW ORLEANS, LA 70160

STATE OF LOUISIANA
DEPARTMENT OF ENVIRONMENTAL
QUALITY
OFFICE OF ENVIRONMENTAL
SERVICES
P.O. BOX 4313
BATON ROUGE, LA 70821-4313

STATE OF LOUISIANA
DEPARTMENT OF NATURAL
RESOURCES
COASTAL MANAGEMENT DIVISION
P.O. BOX 44487
BATON ROUGE, LA 70804-4487

Phone (504) 862- 2041
Fax (504) 862-

Phone (225) 219-3469
Fax (225) 219-3156

Phone (225) 342-0884
Fax (225) 342-9439
Email jay.pecot@la.gov

CORPS REVIEWER:
Robert M. Tewis

DEQ REVIEWER:
Jamie Phillippe

CMD REVIEWER:
Jay Pecot

COE NUMBER:
MVN-2008-0031- ETT

WQC NUMBER:
JP 071206- 02

CUP NUMBER:
P20071504

Interested parties are hereby notified that the Coastal Management Division of the Department of Natural Resources has received the following application for a Coastal Use Permit (CUP) in accordance with the State and Local Coastal Resources Management Act of 1978, as amended, (Louisiana R.S. 49, Sections 214.21-214.41), and the rules and regulations of the Coastal Resources Program.

Additionally, interested parties are hereby notified that applications have been received by the District Engineer for a Department of the Army permit to authorize the following pursuant to: [X] Section 404 of the Clean Water Act (86 Stat. 816; 33 USC 1344) and/or [X] Section 10 of the River and Harbor Act of 1899 (33 USC 403).

Application has also been made to the Louisiana Department of Environmental Quality, Office of Environmental Services for a Water Quality Certification in accordance with statutory authority contained in the Louisiana Revised Statutes of 1950, Title 30, Chapter 11, Part IV, Section 2074 A93) and Provisions of Section 401 of the Clean Water Act (P.O. 95-217).

The official date of the beginning of the public comment period for Coastal Use Permit and Water Quality Certification applications begins on the date of publication of the notice in the official state journal (The Advocate), in accordance with the Rules and Procedures for Coastal Use Permits, §723.C.5.c. The Coastal Management Division will inform interested parties of the exact date of publication on request.

*Habitat impacts are based on available in-house data and may not represent actual conditions. Field reconnaissance may be required verify extent of impacts.

Approximately NO acres of Essential Fish Habitat (EFH) utilized by various life stages of red drum and panfish shrimp would be altered or destroyed by this project. This information is provided to initiate federal consultation requirements pertaining to EFH under the Magnuson-Stevens Fishery Conservation and Management Act.

NAME: ENTERGY LOUISIANA, LLC
c/o SHAW ENVIRONMENTAL & INFRASTRUCTURE, INC.
451 FLORIDA STREET, 10TH FLOOR OFFICE #1029
BATON ROUGE, LA 70801
Attn: Brady Turk

LOCATION: Saint Charles Parish, LA; Lat 30° 0' 19"N / Long -90° 27' 46"W; Section 9 10 T12S R20E; 17420 River Road Montz, 70068

DESCRIPTION: The proposed project is to repower the existing turbine generator by constructing two new boilers fueled by petroleum coke and coal. A continuous barge loading area on the left descending bank of the Mississippi River would be connected to the new facility components by a conveyor system. Petroleum coke, coal and other material (estimated 452,763 cubic yards) will be stock-piled on the facility grounds for immediate and future use.

The repowering project will consist of the addition of two CFB boilers, activated carbon silos, a bed ash silo, a fly ash silo, fuel silos, two limestone and lime silos, as well as one warehouse, conveyors, and ash storage piles. The project will also include a pipeline from a sump located on the dock that will capture stormwater, coal fines, and pet coke fines and transfer the comingled material to the fuel storage area for management.

Excess material excavated from the site will be hauled off by truck for upland disposal (91,212 cubic yards). Material dredged from the Mississippi River will be disposed of in a deep, high velocity section of the Mississippi River (120,000 cubic yards into open water disposal). *Approximately 7.21 acres (29,288 cubic yards - native fill) of wetlands, 60 acres (185,733 cubic yards - excavated material; 65,233 - native fill) of non-wet areas and 53 acres (185,733 cubic yards) of non-vegetated waterbottoms will be impacted resulting from this project.

THE APPLICANT MUST SECURE A STATE COASTAL USE PERMIT PLUS A DEPARTMENT OF THE ARMY PERMIT OR A GENERAL PERMIT AUTHORIZATION FROM THE CORPS OF ENGINEERS. INDEPENDENT EVALUATIONS AND DECISIONS WILL BE MADE BY THE COASTAL MANAGEMENT DIVISION AND THE CORPS OF ENGINEERS.

State of Louisiana Coastal Use Permit Criteria

Plans for the proposed work are now on file and may be inspected at the Office of the Coastal Management Division, Department of Natural Resources, LaSalle Building, 617 North 3rd Street, Room 1048, Baton Rouge, LA . Written comments, including suggestions for modifications or objections to the proposed work and stating the reasons thereof, are being solicited from anyone having an interest in the matter. Comments to the State of Louisiana, Coastal Management Division must be received within 25 days of the date of official journal publication of this notice. Comments may be faxed to us at (225)342-9439 or may be emailed to us at the email address listed above. All comment letters should contain both the applicant's name and the appropriate application number and should be mailed to the Coastal Management Division, Louisiana Department of Natural Resources, P.O. Box 44487, Capitol Station, Baton Rouge, Louisiana 70804-4487.

The decision on whether or not to issue a Coastal Use Permit will be based on an evaluation of the probable impacts of the proposed activity in accordance with the state policies outlined in R.S. 49:214.22. The decision will reflect the national concern for both protection and utilization of important resources. The decision must be consistent with the state program and approved local programs for affected parishes and must represent an appropriate balancing of social, environmental and economic factors. All factors which may be relevant to the proposal will be considered; among these are flood and storm hazards, water quality, water supply, feasible alternative sites, drainage patterns, historical sites, economics, public and private benefits, coastal water dependency, impacts on natural features, compatibility with the natural and culture setting and the extent of long term benefits or adverse impacts.

Certification that the proposed activity will not violate applicable water and air quality laws, standards and regulations will be required before a permit is issued.

State of Louisiana Water Quality Certification Criteria

In accordance with the Joint Public Notice Agreement between Coastal Management Division and the Office of Water Resources, notice is hereby given that the applicant has applied to the Louisiana Department of Environmental Quality, Office of Environmental Services for a Water Quality Certification in accordance with statutory authority contained in the Louisiana Revised Statutes of 1950, Title 30, Chapter 11, Part IV, Section 2074 A(3) and provision of Section 401 of the Clean Water Act (P.L. 95-217).

Comments concerning this application can be filed with the Office of Environmental Services within ten days of this notice to the following address: Louisiana Department of Environmental Quality, Office of Environmental Services, P.O. Box 4313, Baton Rouge, Louisiana 70821-4313.

Additional information is on file with the above office, and may be inspected at any time between 8:00 a.m. and 4:30 p.m. weekdays. Copies may be obtained upon payment of cost of printing. A final decision on this application will be made within 60 days after publication of this notice.

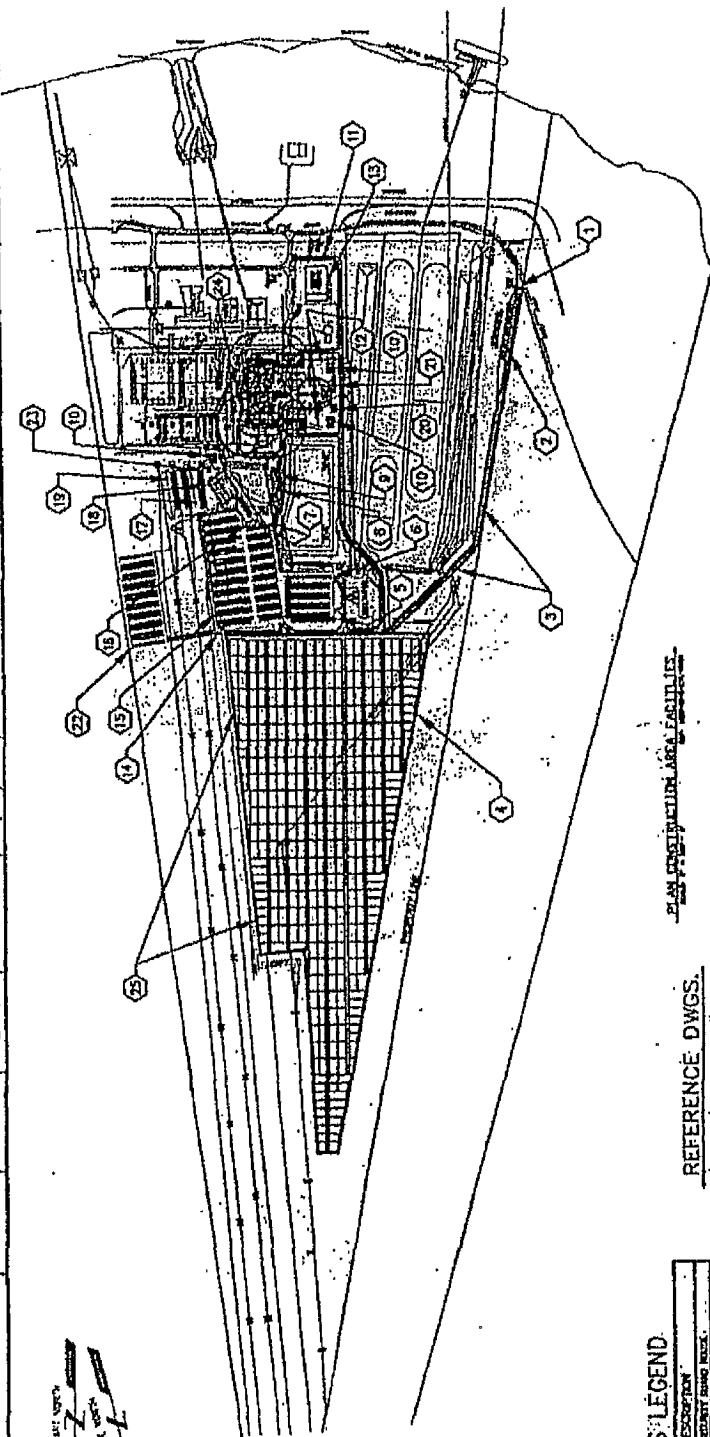
Corps of Engineers Federal Permit Criteria

The notice and notice policies of the Corps of Engineers - New Orleans District can be found on their web page at <http://www.mvn.usace.army.mil/ops/regulatory/publicnotices.asp>.

Public Hearings

Any person may request, in writing, within the comment period specified in this notice, that a State or Federal public hearing be held to consider this application. Request for public hearings shall state, with particularity, the reasons for holding a public hearing.

IMAGE X-REF OFFICE BTR D. COKEAUX 12/17/07 DRAWN BY APPROVED BY DRAWING NUMBER 120581_B29



FACILITIES LEGEND

ITEM #	DESCRIPTION
1	CONTRACTOR STORAGE AREA
2	51' WALK - STORAGE & LUSTERS AREA
3	WALK - CONSTRUCTION ACCESS - 10'x15' ROAD
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REFERENCE DWGS.

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LEGEND

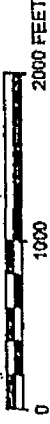
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PLAN CONSTRUCTION AREA FACILITIES

TRANSFORMERS

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SCALE



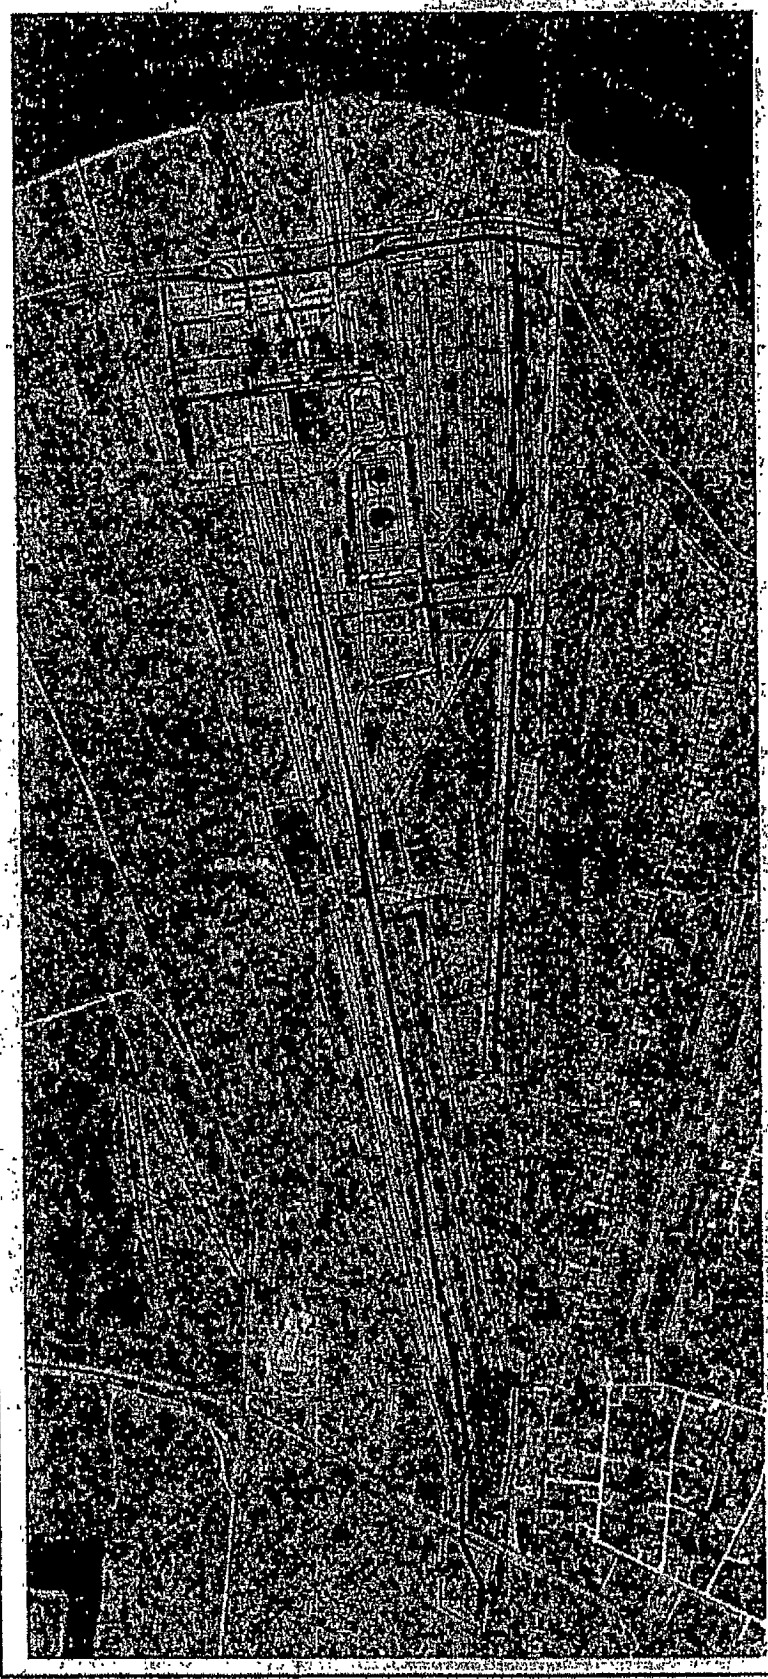
ENTERGY LOUISIANA, LLC
LITTLE GYPSY PLANT
17420 RIVER ROAD
MONTZ, LOUISIANA 70068-9008







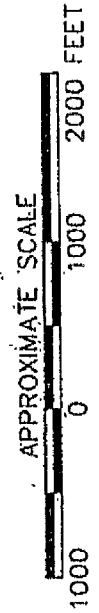
FIGURE 2
SITE PLAN

SECTION 404/10 PERMITTING
MONTZ, ST. CHARLES-PARISH, LOUISIANA

IMAGE X-REF OFFICE DRAWN BY CHECKED BY APPROVED BY DRAWING NUMBER
 BTR BTR J.WOOD 6/05/07 120581_A_0003



-  WATERS OF THE U.S.
-  JURISDICTIONAL WETLANDS
-  IMPACTED WATERS OF THE U.S. (3.79 acres)
-  IMPACTED JURISDICTIONAL WETLANDS (3.42 acres)



ENERGY LOUISIANA, LLC
 LITTLE GYPSY GENERATING PLANT
 17420 RIVER ROAD
 MONTZ, LOUISIANA 70068

FIGURE 3
 2005 AERIAL PHOTOGRAPHY

SECTION 404/10 PERMITTING
 MONTZ, ST. CHARLES PARISH, LOUISIANA

REFERENCE: WASHINGTON GROUP INTERNATIONAL
 DRAWING: SITE PLAN 100-16-11-300-001C.DWG

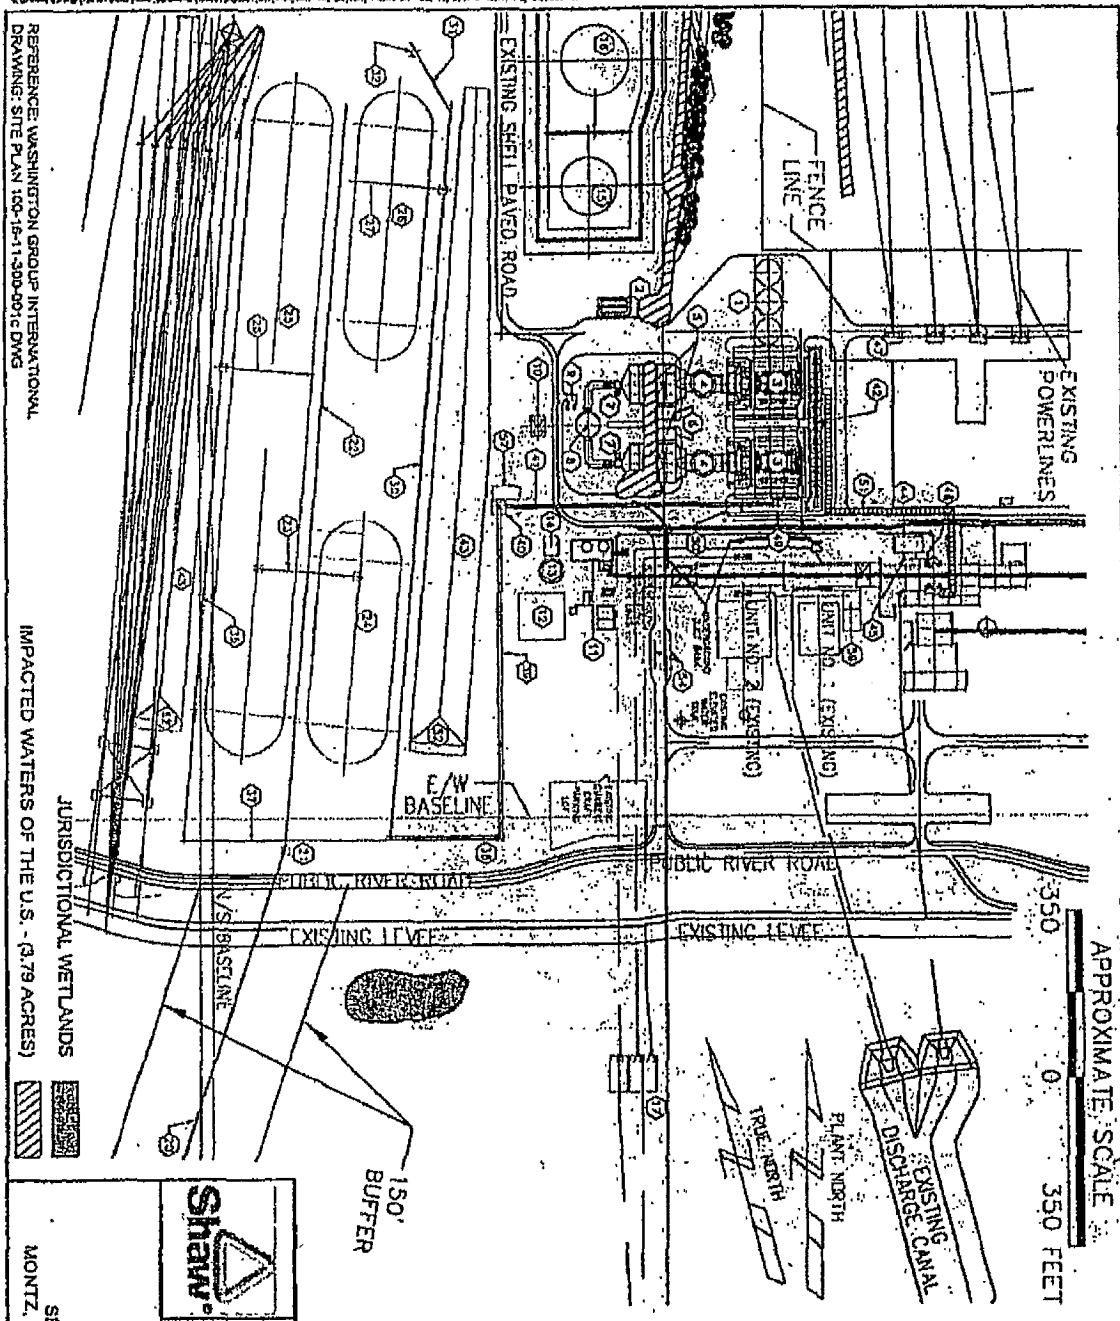


IMAGE X-REF. OFFICE BTR DRAWN BY JWOOD 9/05/07 CHECKED BY APPROVED BY
 DRAWING NUMBER 120581 A.0004

APPROXIMATE SCALE

0 350 FEET 700 FEET

EQUIPMENT LEGEND

NO.	DESCRIPTION
01	ACT. SALES
02	ACT. SALES STORAGE TANKS
03	ACT. SALES STORAGE TANKS - 20,000 GALLONS
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Shaw
 ENTERGY LOUISIANA, LLC
 LITTLE GYPSY GENERATING PLANT
 17420 RIVER ROAD
 MONTZ, LOUISIANA 70068
 SECTION 404/10 PERMITTING
 MONTZ, ST. CHARLES PARISH, LOUISIANA
 FIGURE 4
 SITE PLAN - SOUTH

REFERENCE: WASHINGTON GROUP INTERNATIONAL
 DRAWING: SITE PLAN 100-16-1-300-001c DWG

JURISDICTIONAL WETLANDS
 IMPACTED WATERS OF THE U.S. - (A.79 ACRES)

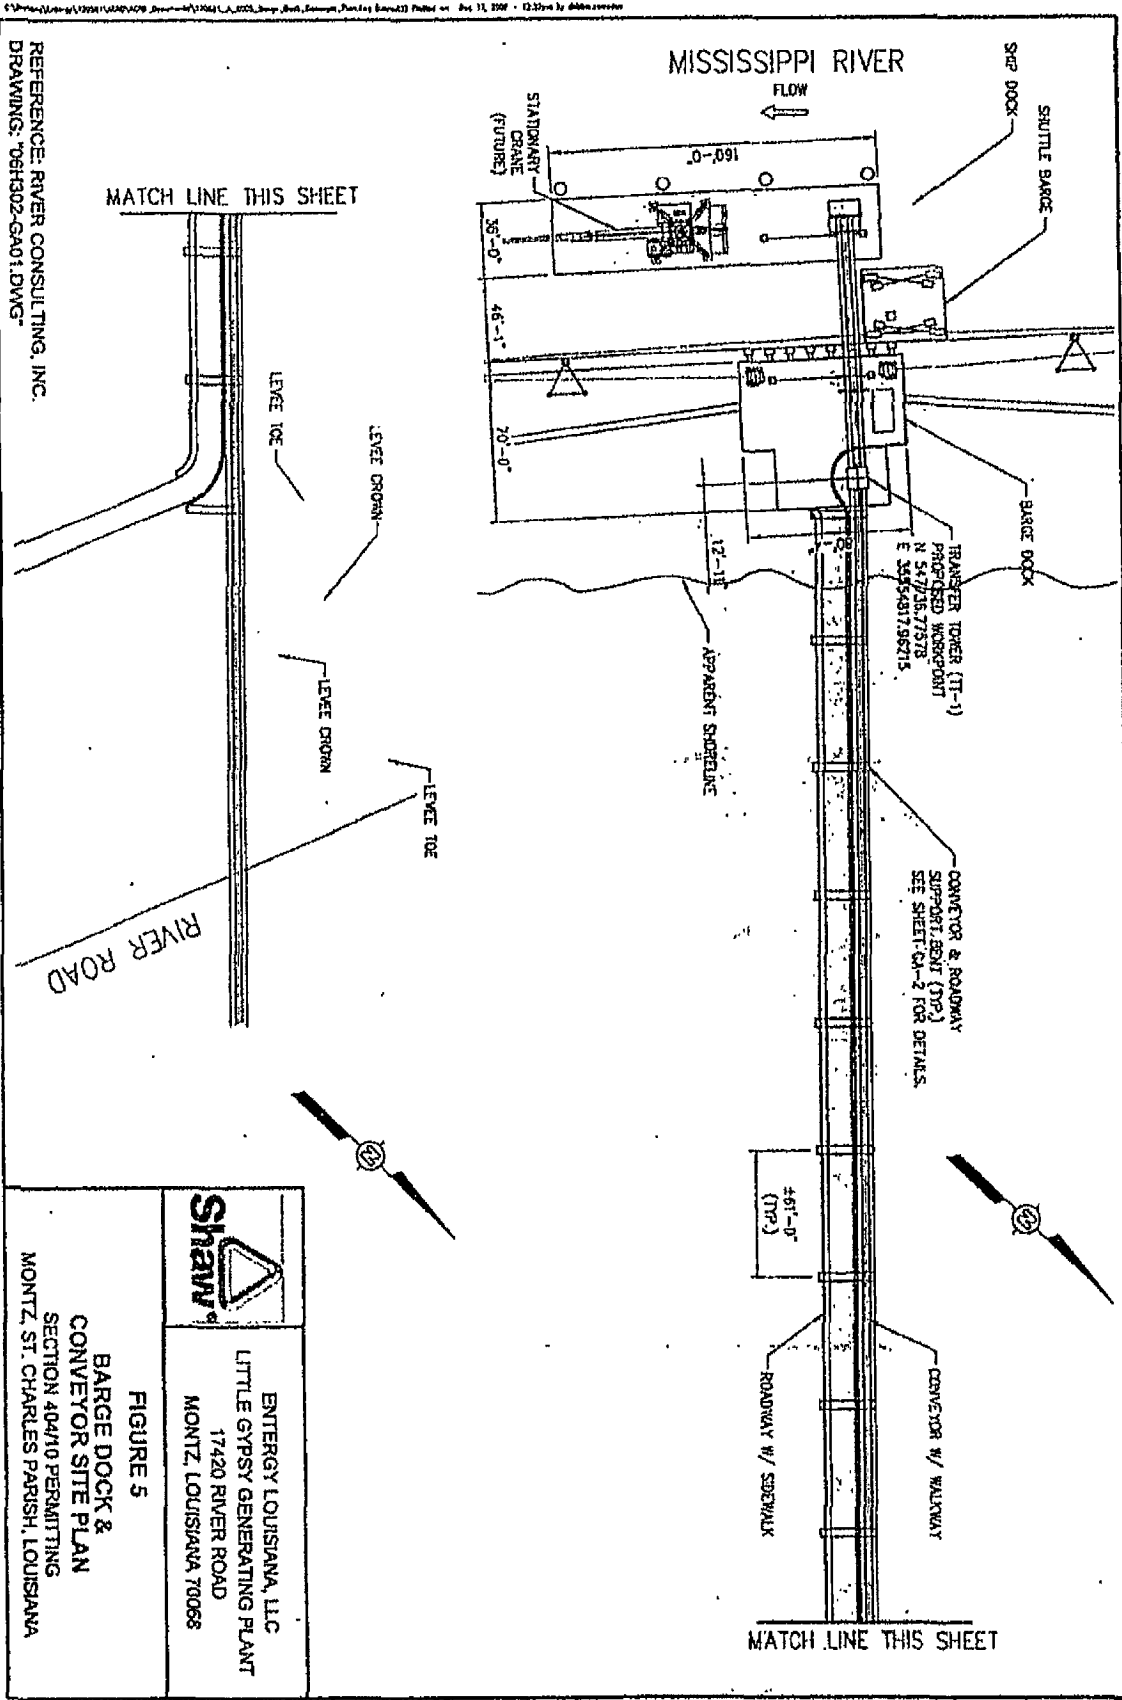


IMAGE	X-REF	OFFICE	DRAWN BY	CHECKED BY	APPROVED BY	DRAWING NUMBER
		STR	4/WOOD	6/05/07		120581_A_0005

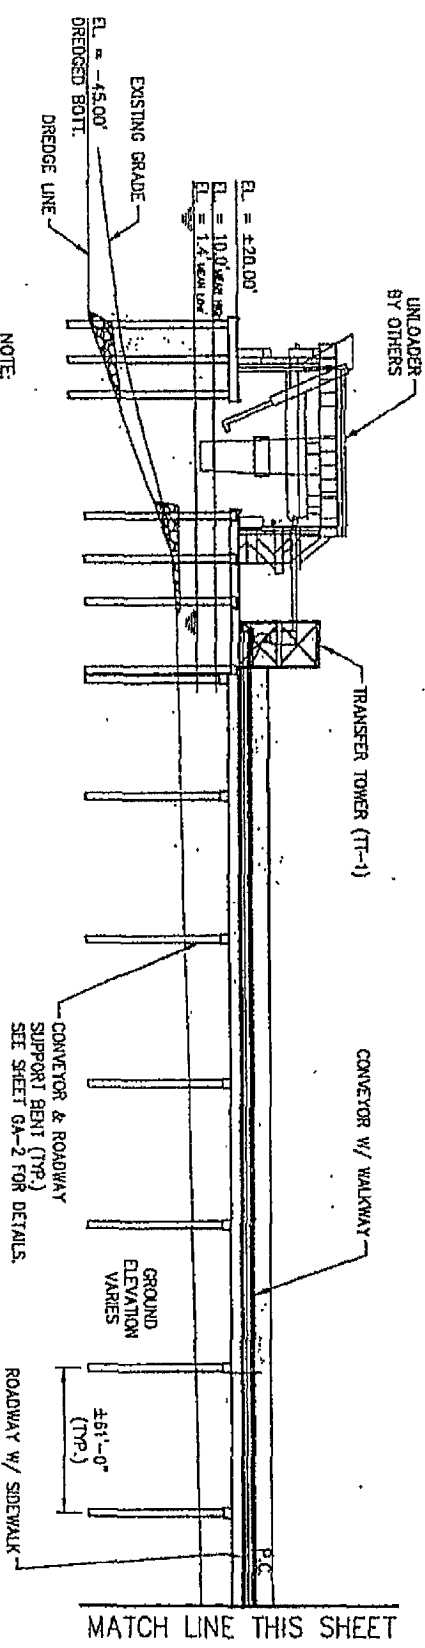
REFERENCE: RIVER CONSULTING, INC.
DRAWING: 06H302-CA01.DWG

Shaw

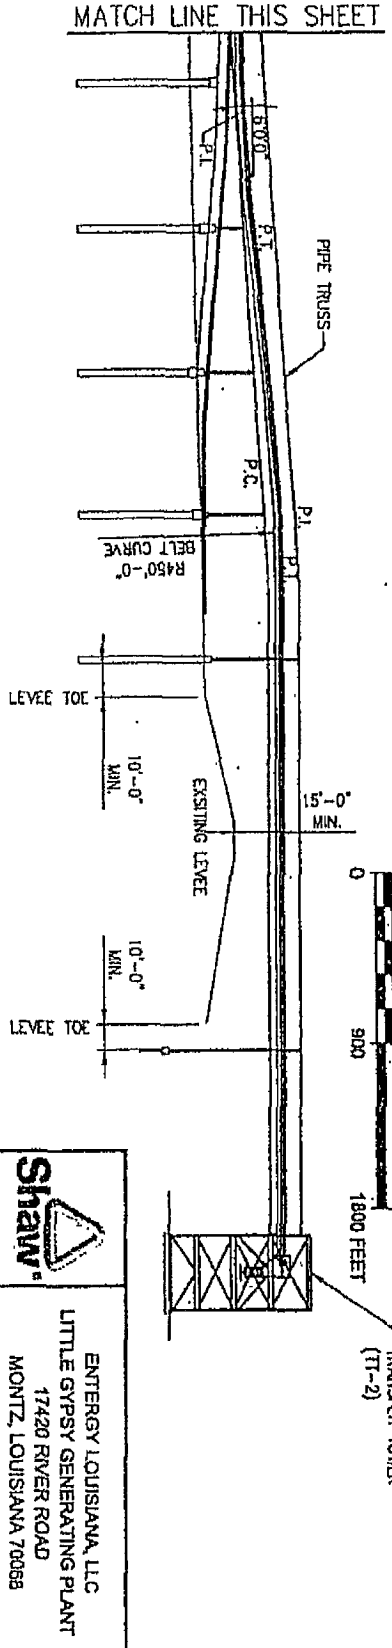
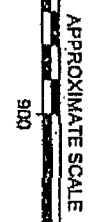
ENERGY LOUISIANA, LLC
LITTLE GYPSY GENERATING PLANT
17420 RIVER ROAD
MONTZ, LOUISIANA 70068

FIGURE 5
BARGE DOCK &
CONVEYOR SITE PLAN
SECTION 404/10 PERMITTING
MONTZ, ST. CHARLES PARISH, LOUISIANA

IMAGE	X-REF.	OFFICE	DRAWN BY	CHECKED BY	APPROVED BY	DRAWING NUMBER
		BTR	J.HOOD 6/05/07			120381_A 0006



NOTE:
 144 YDS STONE FILL
 HYDROGRAPHIC ELEVATIONS REFER TO "ACAD-ENERGY-MONTZ SOUNDINGS" BY BRN CORP. ON 9/2006. JOB # 5549.
 USACE Mississippi River Gauge 01160



NOTE:
 LEVEE ELEVATION AND LOCATION REFER TO "SURVEY OF ENTERGY'S FACILITIES AT LITTLE GYPSY GENERATING STATION SECTIONS 7, 8, 9, 10 & 11" BY LANDMARK SURVEYING, INC. ON 7/18/2006. JOB # 05-0223.

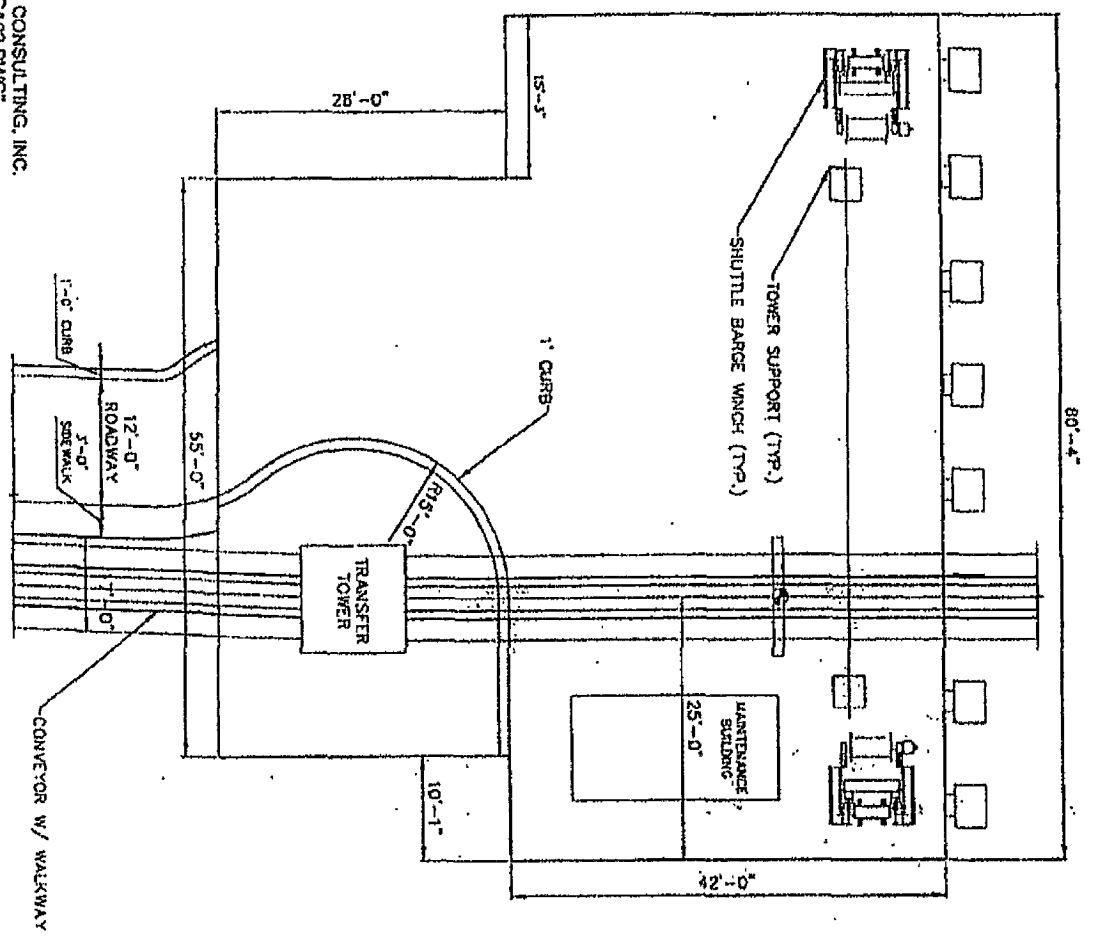
REFERENCE: RIVER CONSULTING, INC.
 DRAWING: 06H302-GA01.DWG

ENTERGY LOUISIANA, LLC
 LITTLE GYPSY GENERATING PLANT
 17420 RIVER ROAD
 MONTZ, LOUISIANA 70068

FIGURE 6
BARGE DOCK & CONVEYOR SITE PROFILE
 SECTION 404/10 PERMITTING
 MONTZ, ST. CHARLES PARISH, LOUISIANA

IMAGE	X-REF	OFFICE	DRAWN BY	CHECKED BY	APPROVED BY	DRAWING NUMBER
		BIR	JHROD 6/25/07			120581 A 0007

REFERENCE: RIVER CONSULTING, INC.
DRAWING: 08H302-GA02.DWG




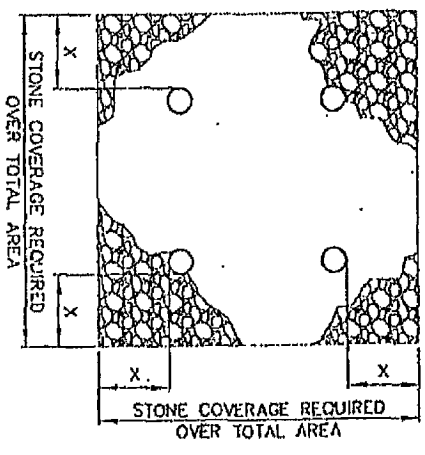
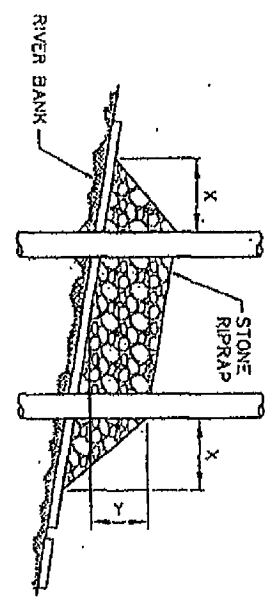
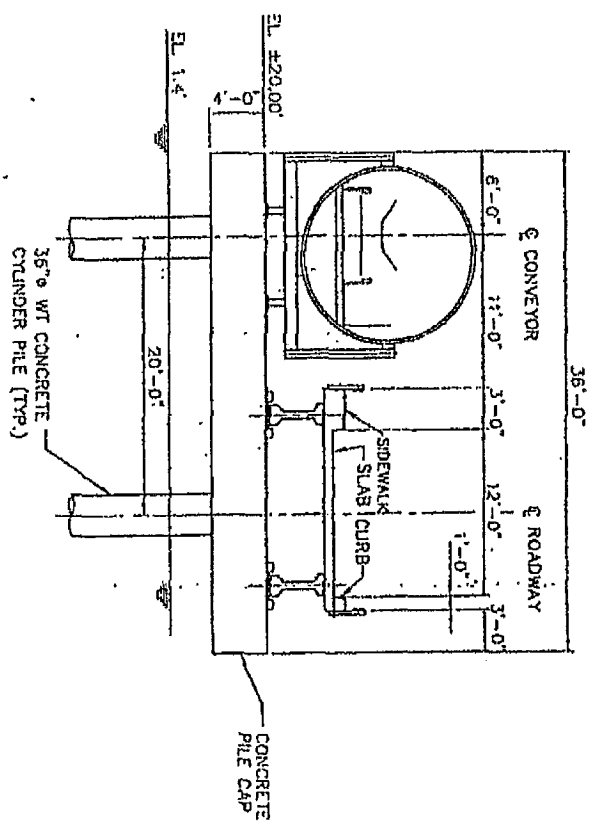
	ENTERGY LOUISIANA, LLC LITTLE GYPSY GENERATING PLANT 17420 RIVER ROAD MONTZ, LOUISIANA 70655
	SECTION 404/10 PERMITTING MONTZ, ST. CHARLES PARISH, LOUISIANA

FIGURE 7
BARGE DOCK PLAN

IMAGE	X-REF	OFFICE	DRAWN BY	CHECKED BY	APPROVED BY	DRAWING NUMBER
		BTR	J.WOOD 6/05/07			120581 A 0008



PILE CLUSTER N.T.S.



TYPICAL BRIDGE/CONVEYOR BENT SECTION N.T.S.

- NOTES:
1. Size of riprap to vary between 6 pounds and 25 pounds with 40% to 80% of the stone within the range of 25 pounds to 75 pounds.
 2. When penetrating Upper Bank Paving in a treatment area with piles, caissons and/or pile clusters, a 10 inch thickness of riprap shall be placed over all areas where bank paving is disturbed by driving operations.

REFERENCE: RIVER CONSULTING, INC.
DRAWING: 08H302-GA02.DWG

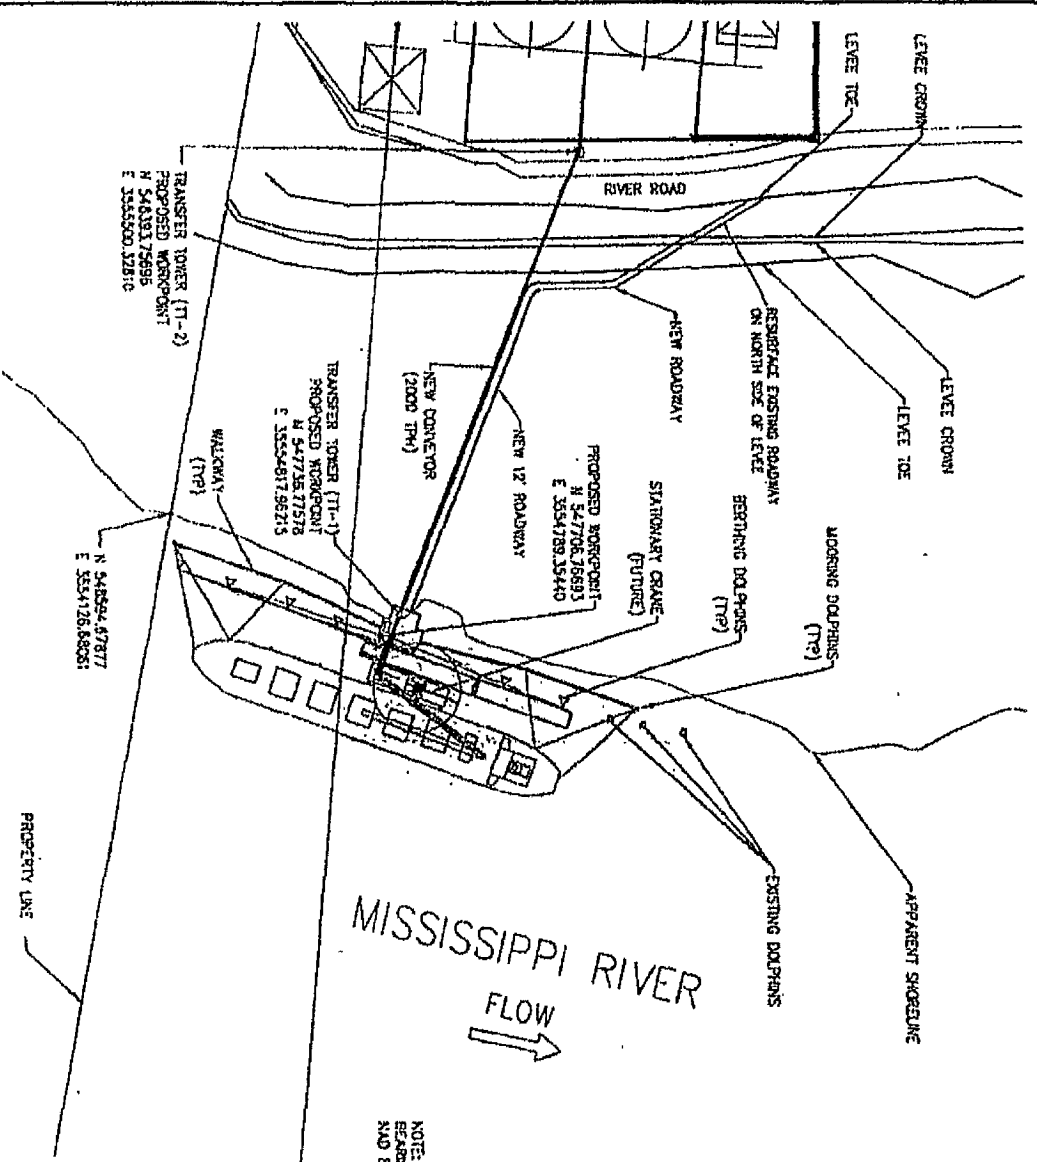
Depth of water in feet at point of penetration at time of stone placement	DIMENSIONS IN FEET FOR PROTECTION AREA REQUIRED				PILE CLUSTER
	PILE	CAISSON	SPUD PILE	CHAIN & BENT	
1 TO 10	3	1 1/2	5	1	1
11 TO 40	5	2	8	3	2
40 TO 60	8	3	12	4	3

Shaw

ENTERGY LOUISIANA, LLC
LITTLE GYPSY GENERATING PLANT
17420 RIVER ROAD
MONTZ, LOUISIANA 70068

FIGURE 8
BRIDGE PILE CLUSTER &
BRIDGE BENT SECTION
SECTION 404/10 PERMITTING
MONTZ, ST. CHARLES PARISH, LOUISIANA

IMAGE	X-REF	OFFICE	DRAWN BY	CHECKED BY	APPROVED BY	DRAWING NUMBER
		BTR	J.MOOD	6/05/07		120581_A_0009



NOTE:
 BEARINGS AND COORDINATES REFER TO JOUGLAZ GRD SOUTH ZONE
 NAD 83 REFERENCED TO CORN STATIONERS FROM GPS SOLUTION.



REFERENCE: RIVER CONSULTING, INC.
 DRAWING: 081302-SP01.DWG


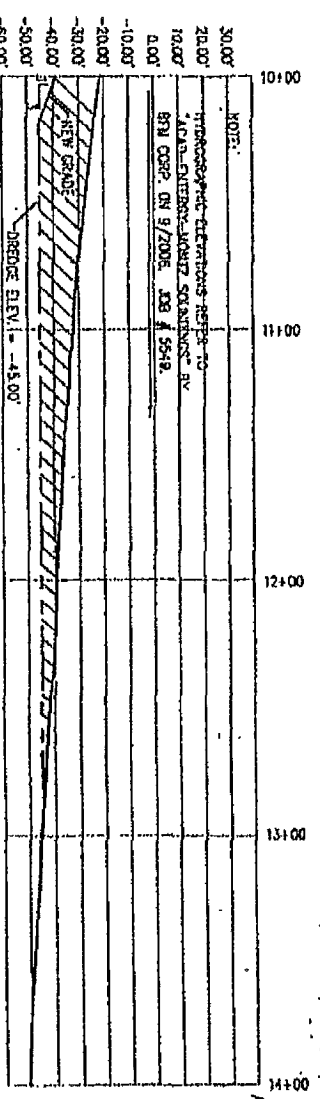
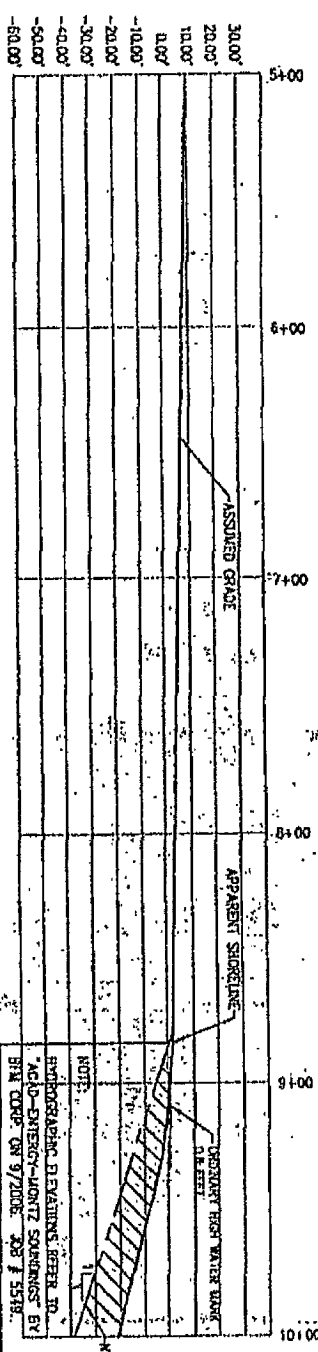
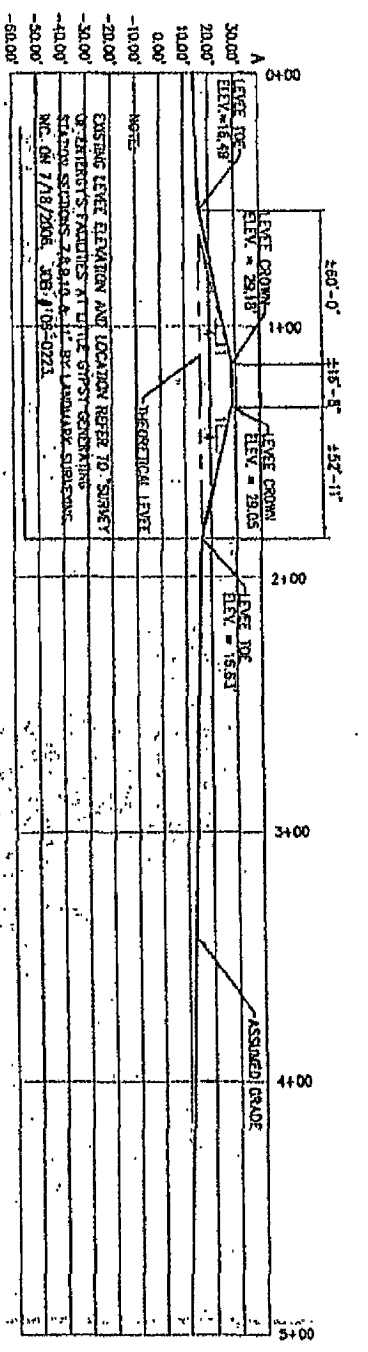
	ENTERGY LOUISIANA, LLC LITTLE GYPSY GENERATING PLANT 17420 RIVER ROAD MONTZ, LOUISIANA 70088
	FIGURE 9 BARGE DOCK SITE PLAN SECTION 404/10 PERMITTING MONTZ, ST. CHARLES PARISH, LOUISIANA

IMAGE	X-REF	OFFICE	DRAWN BY	CHECKED BY	APPROVED BY	DRAWING NUMBER
		BTR	J.WOOD	6/25/07		120581_A_0011



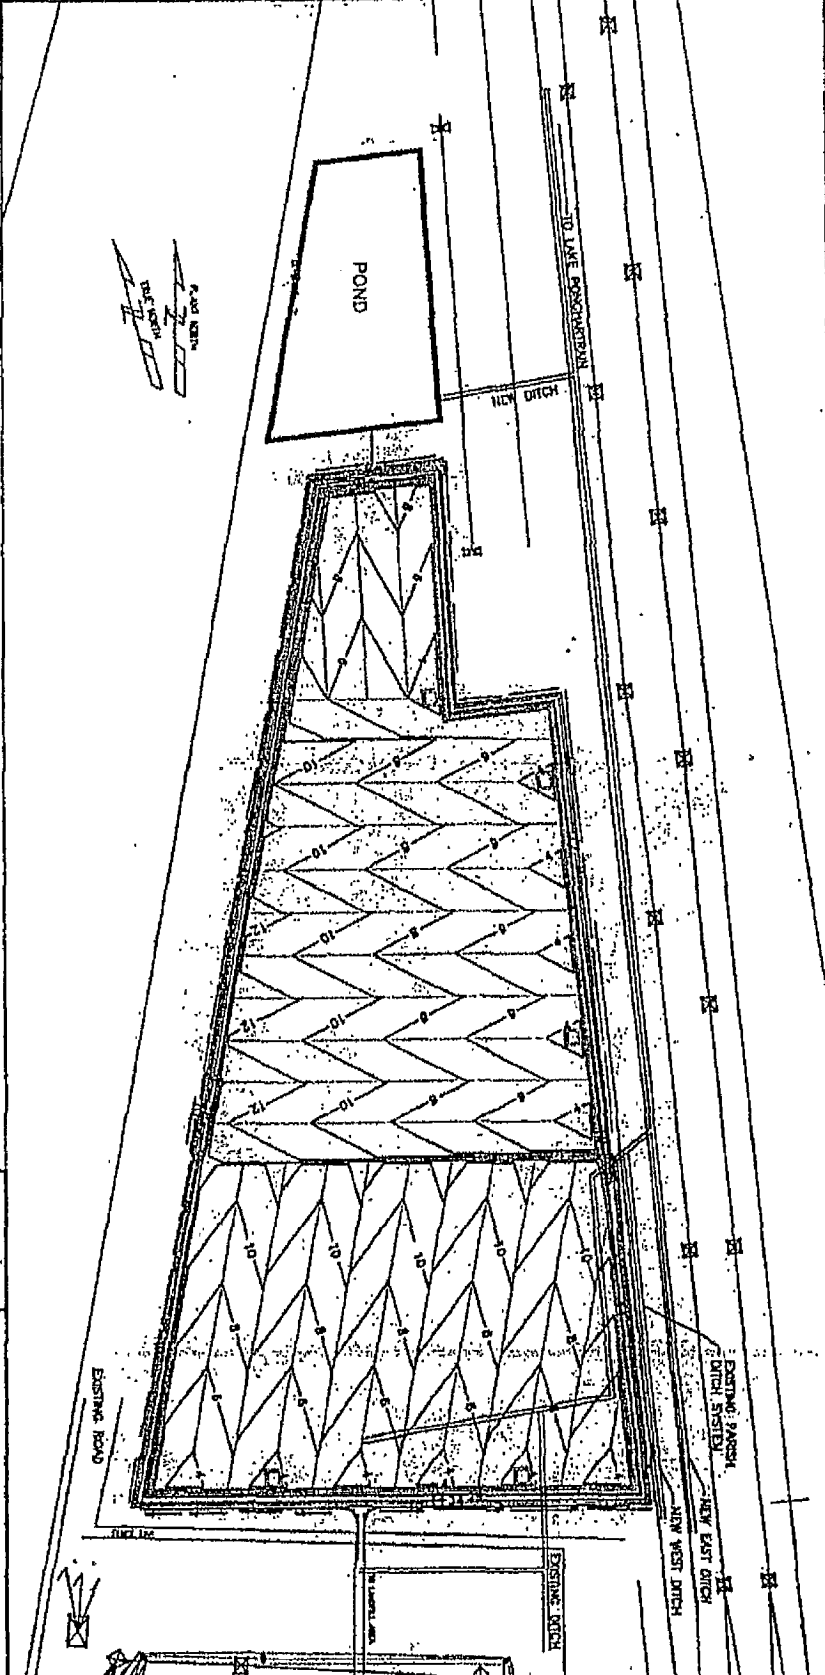
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 DRAWING: "PROFILE.DWG"

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 LITTLE GYPSY GENERATING PLANT
 1742D RIVER ROAD
 MONTZ, LOUISIANA 70068

FIGURE 11
LEVEE PROFILE

SECTION 404/10 PERMITTING
 MONTZ, ST. CHARLES PARISH, LOUISIANA

IMAGE	X-REF	OFFICE	DRAWN BY	CHECKED BY	APPROVED BY	DRAWING NUMBER
		BTR	D. COMEAU	12/17/02		120581_B20

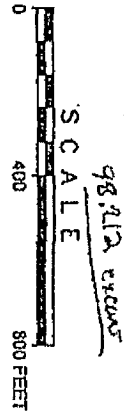



- LEGEND**
- ASH BOUNDARY
 - HIGH POINT
 - TOP OF UNDER CONCRETE
 - EXISTING TOPOGRAPHY
 - SLOPE
 - TOP OF BEAM
 - PROPOSED DRAINAGE DITCH

CUT/FILL VOLUME CALCULATIONS

(Cubic Yards)

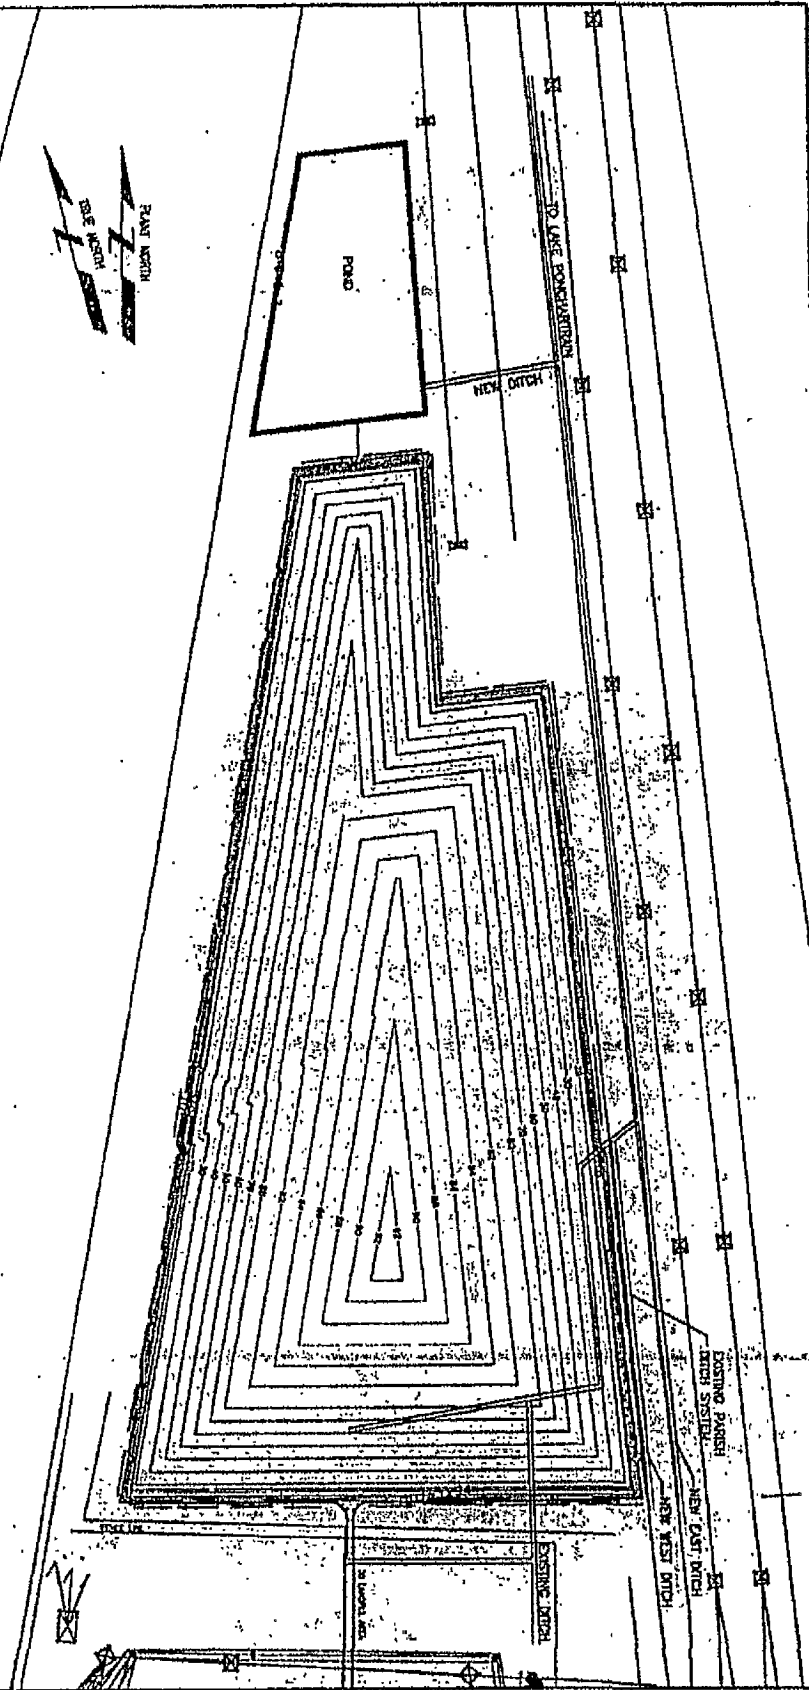
AREA	SURF	REL	NET
ASH-BOUNDARY	124,703 CY	6,433 CY	38,317 CY CUT
POND	38,201 CY	0 CY	38,201 CY CUT

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 LITTLE GYPSY PLANT
 17420 RIVER ROAD
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FIGURE 12
 ASH STORAGE AREA
 BASE GRADE PLAN
 SECTION 404/10 PERMITTING
 MONTZ, ST. CHARLES PARISH, LOUISIANA

IMAGE	X-REF	OFFICE	DRAWN BY	CHECKED BY	APPROVED BY	DRAWING NUMBER
		BTR	D. COMEAU	12/17/07		120581_B21



TOTAL ASH AIRSPACE
(AS PER TABLE)

AREA	GRAD	FILL	MT
BASE GRADE - FINAL GRADE	0 FT	3,862,150 CY	3,862,150 CY

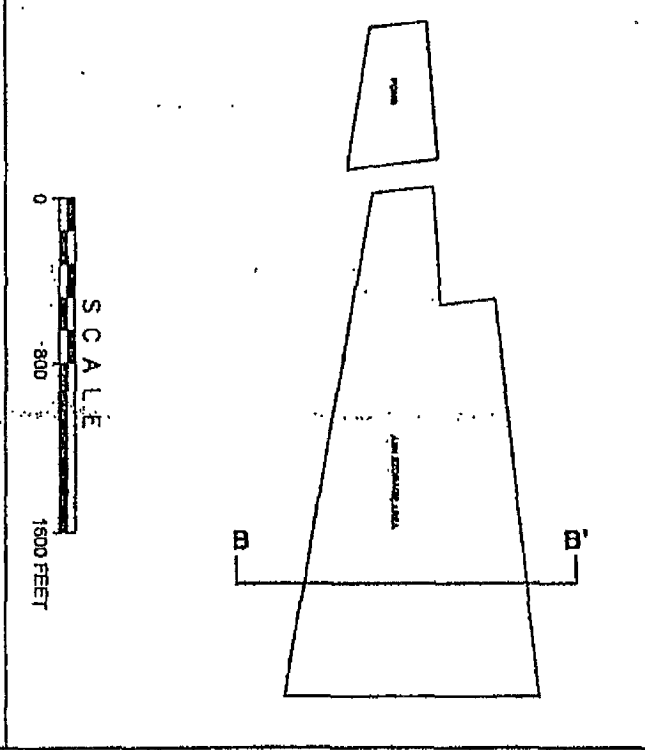
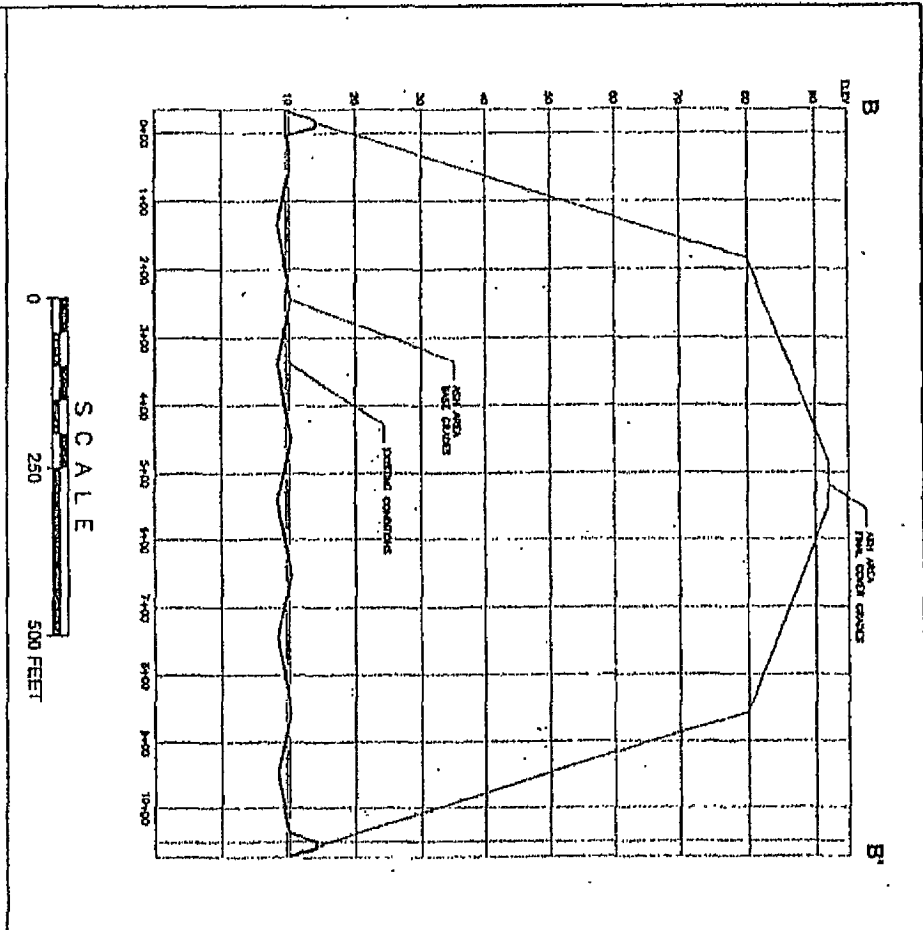
NOTE:
ASH AIRSPACE VOLUME CALCULATED FROM TOP OF BASE GRADE TO TOP OF FINAL GRADE.



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FIGURE 13
ASH STORAGE AREA
FINAL GRADING PLAN
SECTION 406/10 PERMITTING
MONTZ, ST. CHARLES PARISH, LOUISIANA

IMAGE	X-REF	OFFICE	DRAWN BY	CHECKED BY	APPROVED BY	DRAWING NUMBER
		BTR	D. COMEAU			120581_B22




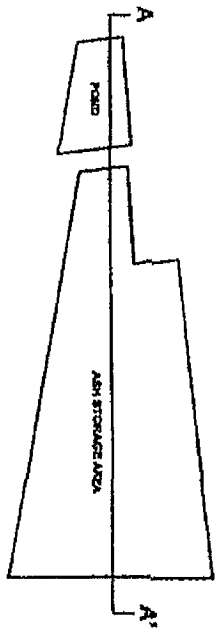
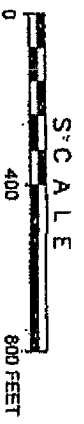
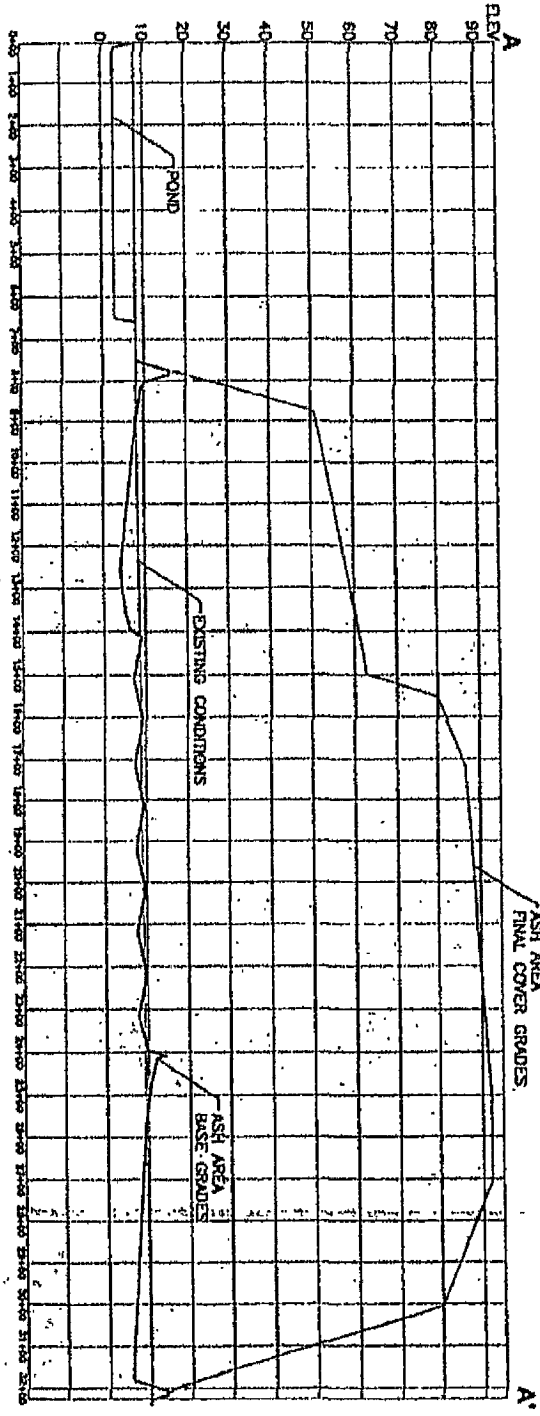

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FIGURE 14
 CROSS SECTION B - B'
 EAST AND WEST
 SECTION 404/10 PERMITTING
 MONTZ ST. CHARLES PARISH, LOUISIANA

IMAGE	X-REF	OFFICE	DRAWN BY	CHECKED BY	APPROVED BY	DRAWING NUMBER
		BTR	D. COMEAU			120581_B23

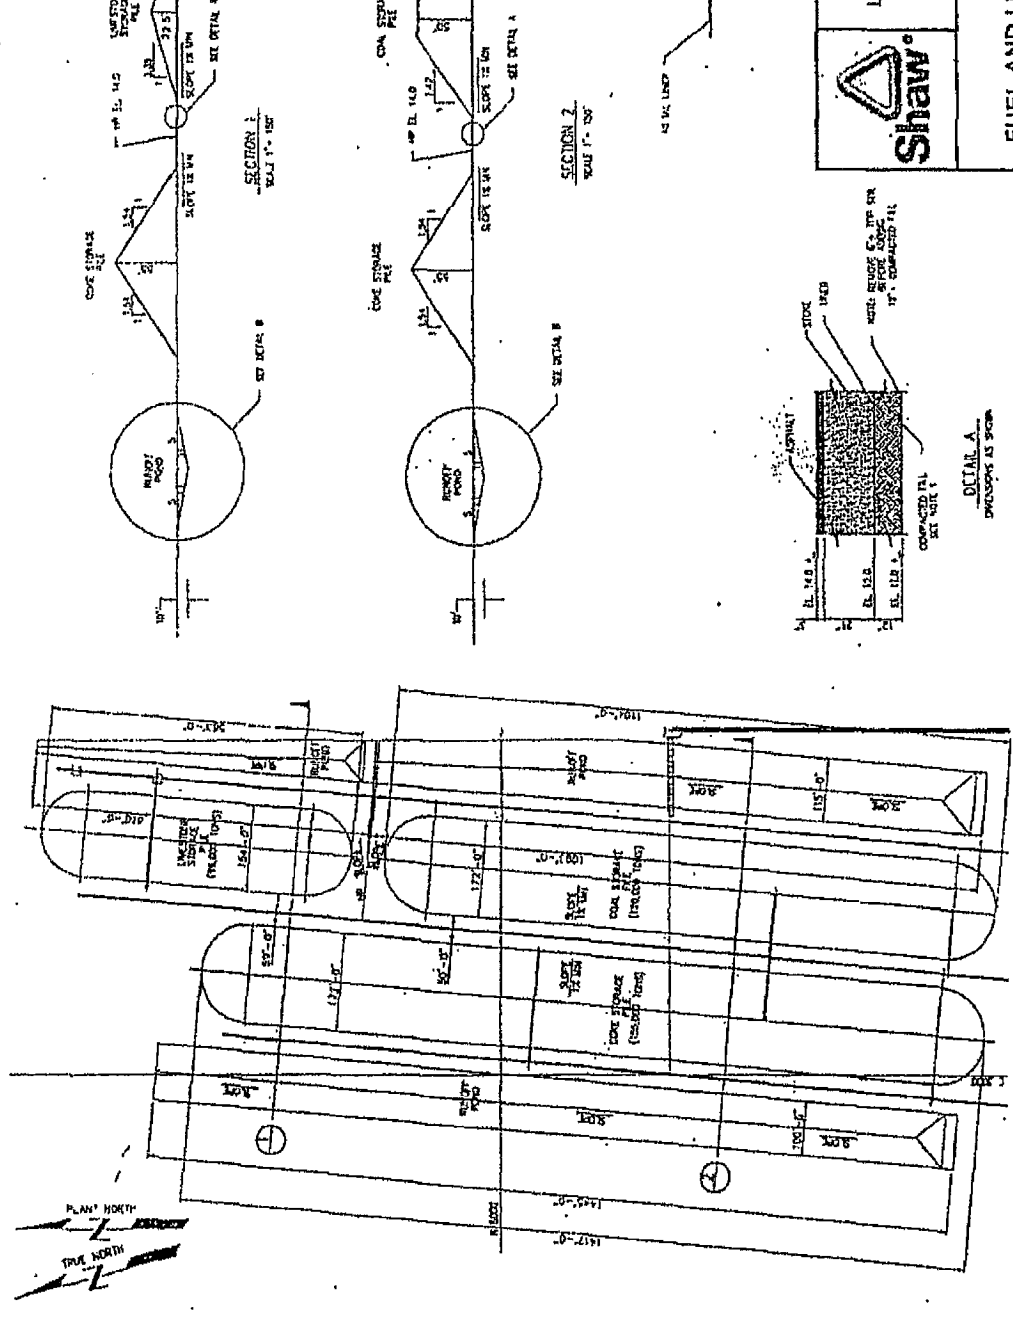


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FIGURE 15
CROSS SECTION A - A'
NORTH AND SOUTH
SECTION 404/10 PERMITTING
MONTZ, ST. CHARLES PARISH, LOUISIANA

IMAGE	X-REF	OFFICE	BTR	DRAWN BY	CHECKED BY	APPROVED BY	DRAWING NUMBER
				E. HOLT			120581.04_A02

NOTES
 1. RAINST POND EXCAVATED MATERIAL TO BE REUSED AS FILL



PRELIMINARY
 FOR INFORMATION ONLY

PLAN AT STORAGE PILES
 SCALE 1" = 30'



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 LITTLE GYPSY GENERATING PLANT
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FIGURE 16
 FUEL AND LIMESTONE STORAGE AREA
 LAYOUT AND CROSS-SECTIONS
 SECTION 404/10 PERMITTING
 MONTEZ, ST. CHARLES PARISH, LOUISIANA

cc: pc
 crm