


RIVER - LAKE DRIVE (EVANGELINE ROAD)
ST. CHARLES PARISH, LOUISIANA

SITE LAYOUT
SCALE: 1/16" = 1'-0"

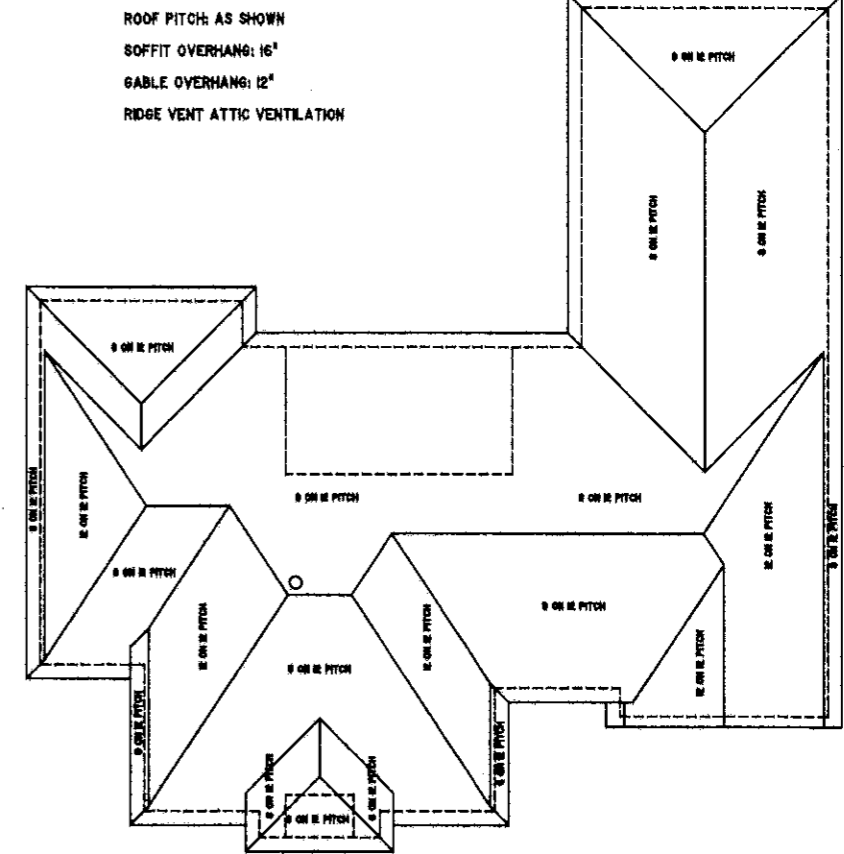


ROOF PITCH: AS SHOWN
SOFFIT OVERHANG: 16"
GABLE OVERHANG: 12"
RIDGE VENT ATTIC VENTILATION


ROOF LAYOUT
SCALE: 1/8" = 1'-0"



FRONT ELEVATION
SCALE: 1/4" = 1'-0"

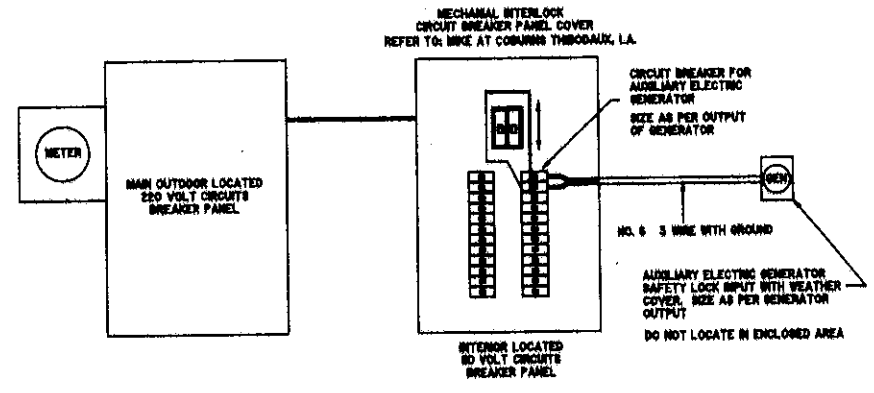

METHOD OF INSTALLING MAIN CIRCUIT BREAKER PANEL AND SUB PANEL WITH MOBILE ELECTRIC GENERATOR CIRCUIT

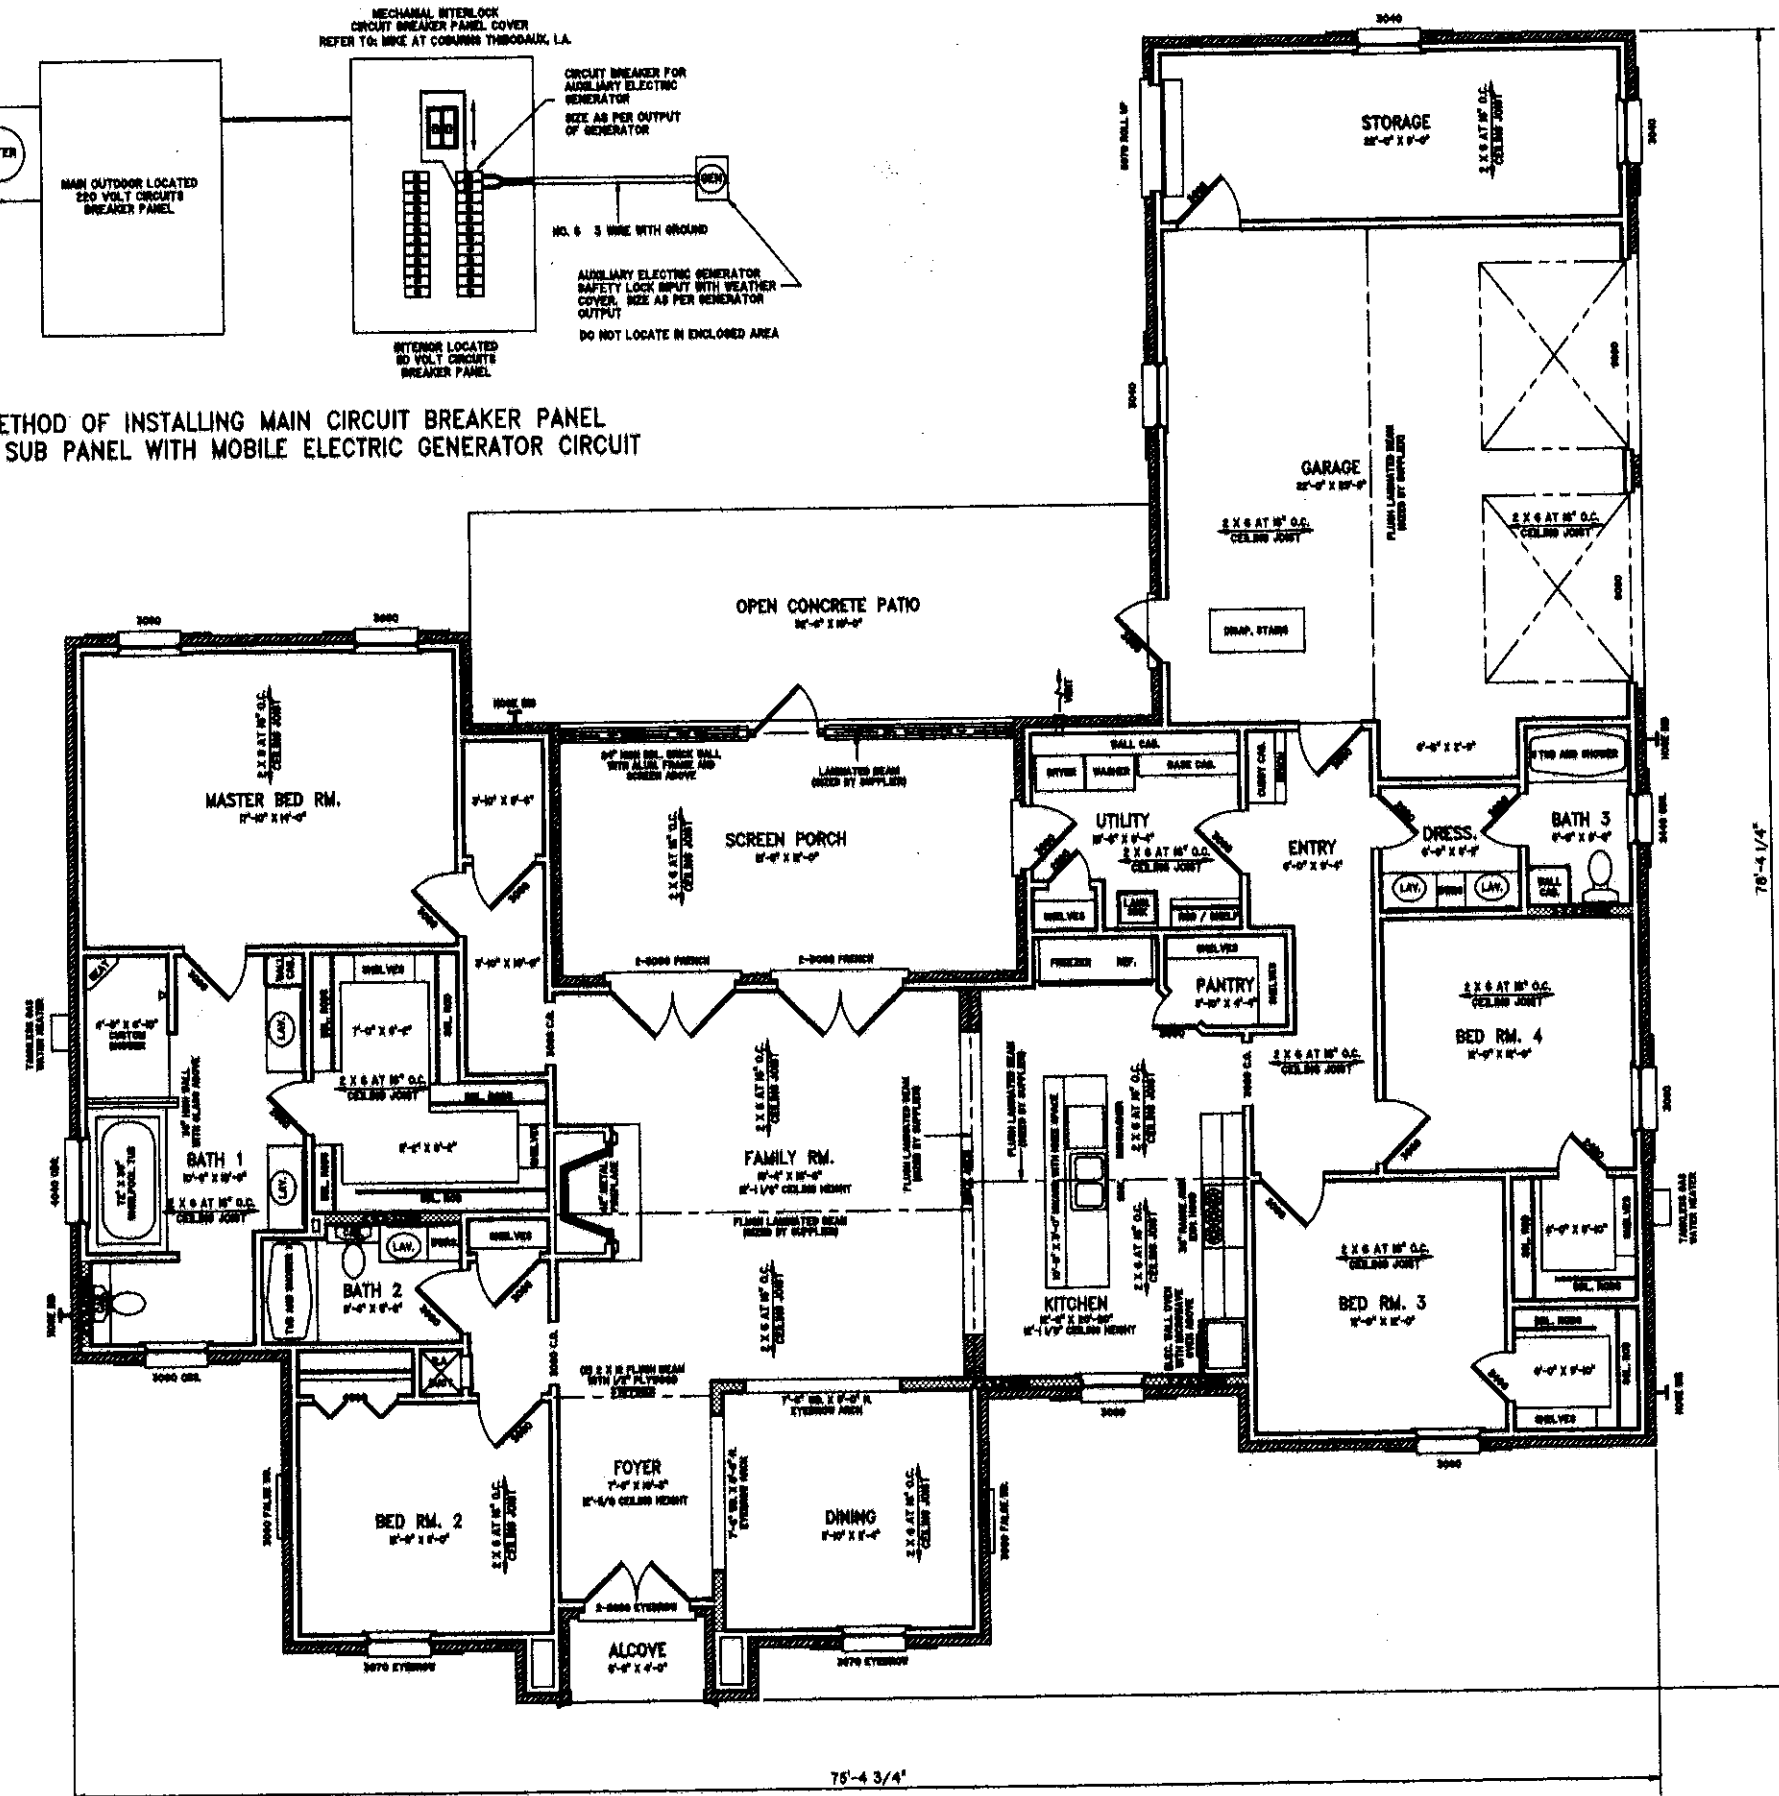


10'-1 1/8" TYPICAL CEILING HEIGHT UNLESS OTHERWISE NOTED
 PROVIDE AN APPROVED WASTE TREATMENT SYSTEM

————— DENOTES 2 X 6 AT 16" O.C. WALL STUDS

2632 SQ. FT. LIVING AREA
35 SQ. FT. FRONT ALCOVE
261 SQ. FT. SCREEN PORCH
903 SQ. FT. GARAGE / STORAGE
3731 SQ. FT. TOTAL AREA

PRELIMINARY FLOOR PLAN
 SCALE: 1/4" = 1'-0"


RESIDENCE FOR JUSTIN & LYNN NAQUIN		 DONALD A. THIBODAUX PROFESSIONAL ENGINEER <small>STATE OF MISSISSIPPI</small> <small>NO. 10000</small> <small>EXPIRES 12/31/2008</small>
504-628-2506		
SHEET 1 OF 4	DRAWING NO. 21807-2-1	

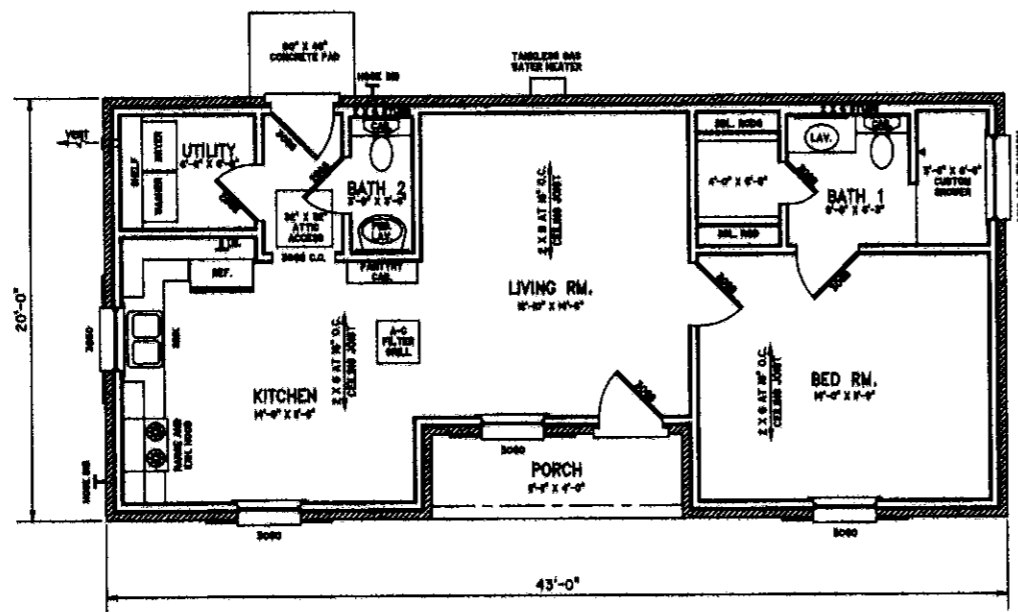

PRELIMINARY FLOOR PLAN
SCALE: 1/4" = 1'-0"

9'-1 1/8" TYPICAL CEILING HEIGHT

814 SQ. FT. LIVING AREA
46 SQ. FT. PORCH
<hr/> 860 SQ. FT. TOTAL AREA

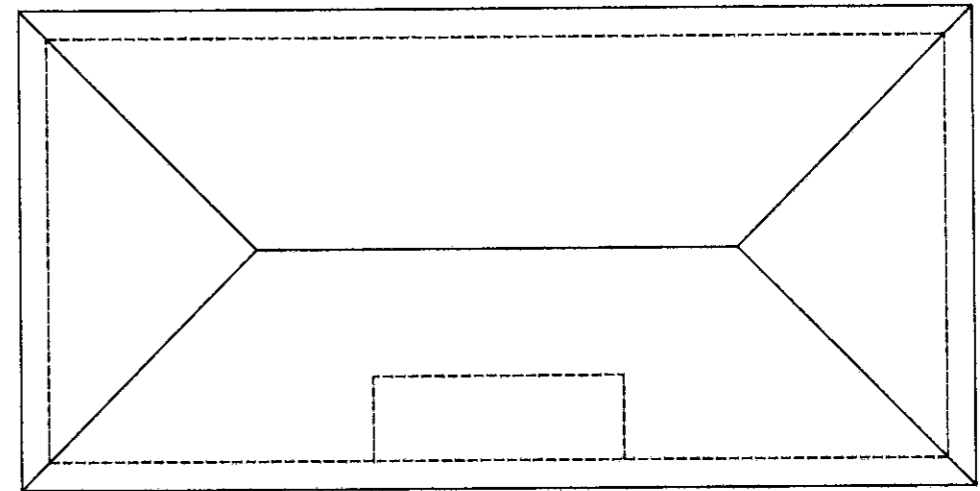

ROOF LAYOUT
SCALE: 1/4" = 1'-0"

ROOF PITCH: 6 ON 12
SOFFIT OVERHANG: 16"
RIDGE VENT ATTIC VENTILATION



FRONT ELEVATION
SCALE: 1/4" = 1'-0"